

30'

15

Scale: 1"=30'

SITE DATA

PARCEL ID:

CURRENT ZONING:

CAMA LAND USE CLASSIFICATION: PROJECT ADDRESS:

CURRENT OWNERS:


TOTAL ACREAGE IN PROJECT BOUNDARY: EXISTING IMPERVIOUS AREAS: SITE IS VACANT


R05619-005-008-000, R05619-005-007-000 & R05619-005-009-000 R-5 (CD)


WATERSHED RESOURCE PROTECTION 101, 109 GREENVILLE AVE., 6015 PARK AVE. WILMINGTON, NC 28403

THREE FEATHERED FRIENDS LLC 1601 LIMPKIN CT. WILMINGTON, NC 28403 50,897 S.F. (1.17 AC.)

NOTES: 1. EXISTING SURVEY INFORMATION PROVIDED BY PATRICK C. BRISTOW N.C. PLS No. L-4148 SURVEY DATED 1/24/18. 2. THIS LOT IS LOCATED IN ZONE X AS PER FIRM COMMUNITY # 370171, MAP# 3720315700 - K, DATED: AUGUST 28, 2018. 3. SOIL TYPE: Le (Leon Sand) and Wa (Wakulla Sand)

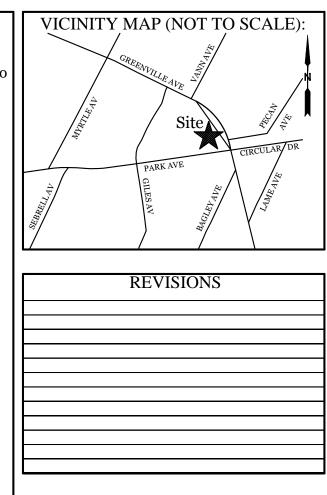

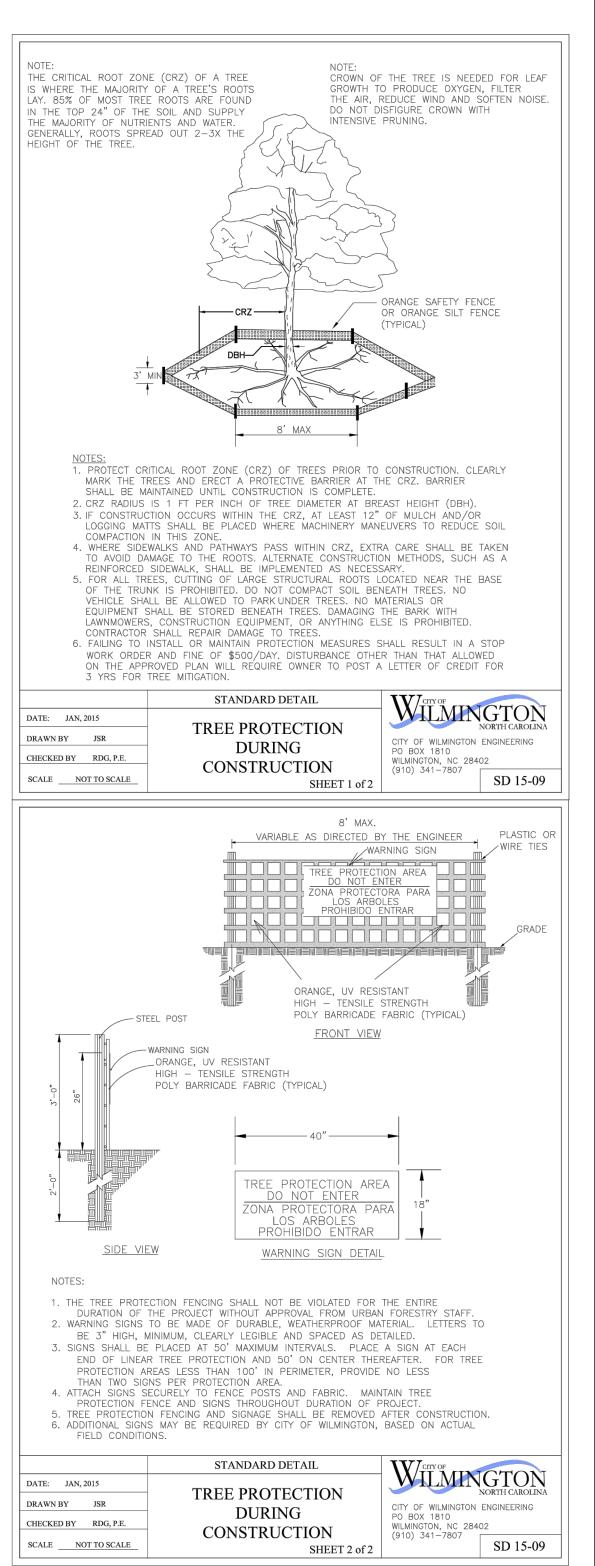


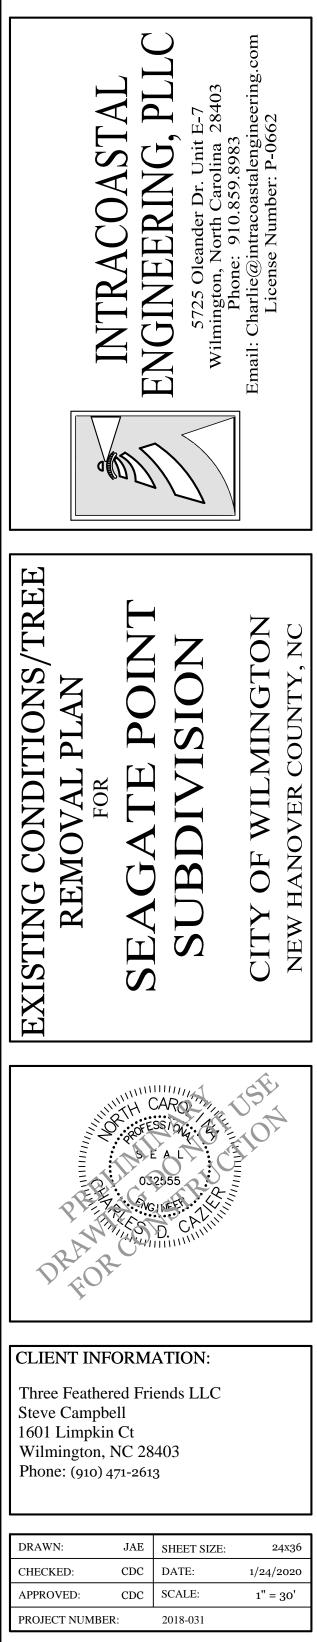

DRAWING NUMBER:

C-0

1 OF 5

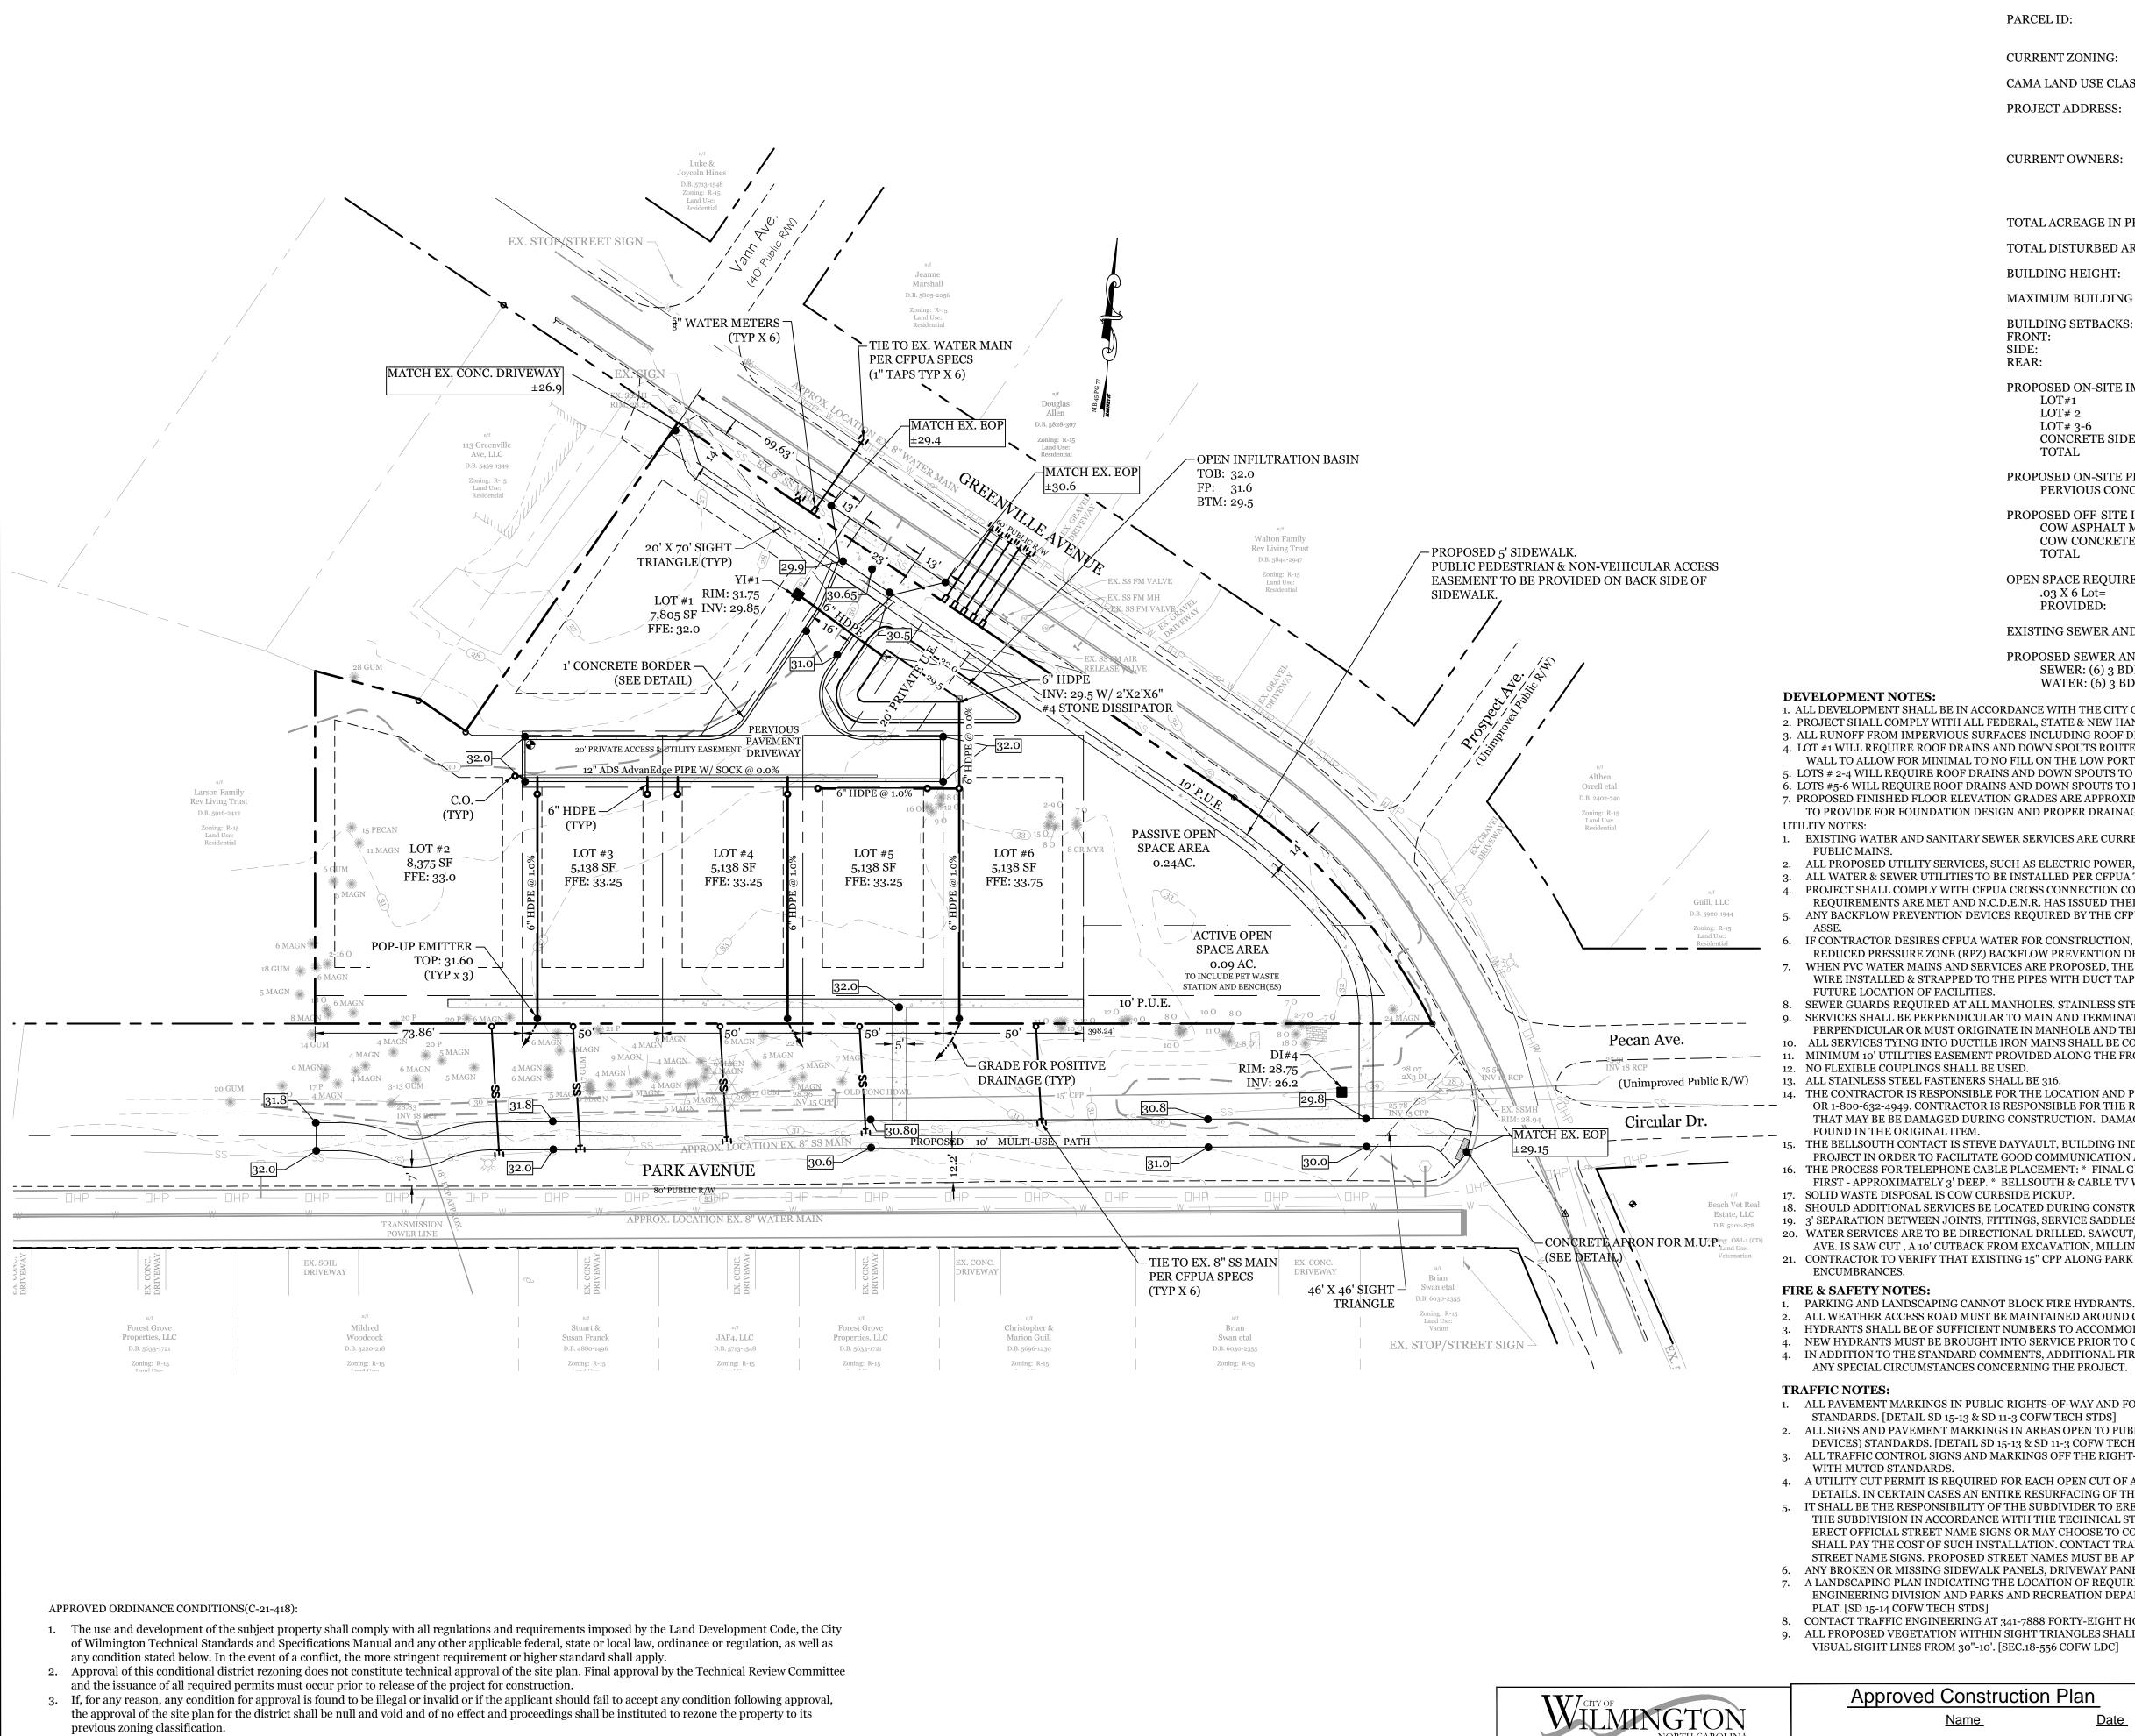

4. All landscaping and buffers shall be installed in accordance with Land Development Code.

5. The use and development of the subject property shall be in accordance with the site plan and elevations as submitted (dated received, 4/10/18) 6. The common area shall contain a pet waste station and benches (dated received, 4/10/18).

- 7. All existing protected trees not impacted by essential site improvements shall be preserved. Preservation of existing trees shall be included in the overall design of the project as submitted on the site plan (dated received, 4/10/18),
- 8. Pedestrian connection shall be provided from each structure to the public pedestrian infrastructure.
- 9. The proposed density shall be limited to 6 single family structures.
- 10. Strict adherence to the design standards will be confirmed as part of the technical review.
- 11. All City, State and Federal regulations shall be met.

VISUAL SIGHT LINES FROM 30"-10'. [SEC.18-556 COFW LDC]

Approved Cons Name lannin APPROVED STORMWATER MANAGEMENT PLAN | Public Utilities

Public Services • Engineering Division

Permit #

SITE DATA

PARCEL ID:

CURRENT ZONING: CAMA LAND USE CLASSIFICATION: **PROJECT ADDRESS:**

CURRENT OWNERS:

TOTAL ACREAGE IN PROJECT BOUNDARY: TOTAL DISTURBED AREA:

BUILDING HEIGHT: MAXIMUM BUILDING LOT COVERAGE:

BUILDING SETBACKS: FRONT:

SIDE: **REAR:**

PROPOSED ON-SITE IMPERVIOUS AREAS: LOT#1 LOT# 2

LOT# 3-6 CONCRETE SIDEWALK CURB, ETC. TOTAL

PROPOSED ON-SITE PERVIOUS AREAS: PERVIOUS CONCRETE DRIVEWAY

PROPOSED OFF-SITE IMPERVIOUS AREAS: COW ASPHALT MULTI-USE PATH 4,145 S.F. COW CONCRETE SIDEWALK/DW APRON 2,532 S.F. TOTAL

OPEN SPACE REQUIREMENT: (0.03 AC. per Lot) .03 X 6 Lot= **PROVIDED:**

EXISTING SEWER AND WATER DEMAND:

PROPOSED SEWER AND WATER DEMAND:

SEWER: (6) 3 BDRM RES. @ 360 GAL/RES. = 2,160 GPD WATER: (6) 3 BDRM RES. @ 400 GAL/RES. = 2,400 GPD

1. ALL DEVELOPMENT SHALL BE IN ACCORDANCE WITH THE CITY OF WILMINGTON LAND DEVELOPMENT CODE.

2. PROJECT SHALL COMPLY WITH ALL FEDERAL, STATE & NEW HANOVER COUNTY REGULATIONS

3. ALL RUNOFF FROM IMPERVIOUS SURFACES INCLUDING ROOF DRAINS TO BE ROUTED TO STORMWATER SYSTEM. 4. LOT #1 WILL REQUIRE ROOF DRAINS AND DOWN SPOUTS ROUTED TO YARD INLET#1. WEST FOUNDATION WALL TO BE EXPOSED AS A RETAINING WALL TO ALLOW FOR MINIMAL TO NO FILL ON THE LOW PORTION OF LOT.

R05619-005-008-000, R05619-005-007-000

WATERSHED RESOURCE PROTECTION

THREE FEATHERED FRIENDS LLC

& R05619-005-009-000

101, 109 GREENVILLE AVE.,

WILMINGTON, NC 28403

WILMINGTON, NC 28403

R-5 (CD)

1.3 AC.

35' MAX

50%

6015 PARK AVE.

1601 LIMPKIN CT.

50,897 S.F. (1.17 AC.)

REQUIRED= 20'

REQUIRED=7'

REQUIRED= 15

10,985 S.F. (21.6%)

6,000 S.F. (1500 S.F. PER LOT)

0.18 AC (MIN 50% ACTIVE)

0.33 AC (0.09 ACTIVE)

o GPD (VACANT)

1,800 S.F.

2,000 S.F.

1,185 S.F.

3,226 S.F.

6.677 S.F.

5. LOTS # 2-4 WILL REQUIRE ROOF DRAINS AND DOWN SPOUTS TO BE PIPED INTO PERVIOUS CONCRETE STONE BASE. 6. LOTS #5-6 WILL REQUIRE ROOF DRAINS AND DOWN SPOUTS TO BE PIPED INTO OPEN INFILTRATION BASIN #1.

7. PROPOSED FINISHED FLOOR ELEVATION GRADES ARE APPROXIMATE. OWNER/BUILDER MAY BE REQUIRED TO RAISE FINISHED FLOOR GRADES TO PROVIDE FOR FOUNDATION DESIGN AND PROPER DRAINAGE.

1. EXISTING WATER AND SANITARY SEWER SERVICES ARE CURRENTLY AVAILABLE TO THE SITE FROM CAPE FEAR PUBLIC UTILITY AUTHORITY 2. ALL PROPOSED UTILITY SERVICES, SUCH AS ELECTRIC POWER, CATV, GAS & TELEPHONE SHALL BE INSTALLED UNDERGROUND.

ALL WATER & SEWER UTILITIES TO BE INSTALLED PER CFPUA TECHNICAL SPECIFICATIONS & STANDARDS PROJECT SHALL COMPLY WITH CFPUA CROSS CONNECTION CONTROL REQUIREMENTS. WATER METER(S) CANNOT BE RELEASED UNTIL ALL REQUIREMENTS ARE MET AND N.C.D.E.N.R. HAS ISSUED THEIR "FINAL APPROVAL.". CALL 332-6558 FOR INFORMATION. 5. ANY BACKFLOW PREVENTION DEVICES REOUIRED BY THE CFPUA WILL NEED TO BE ON THE LIST OF APPROVED DEVICES BY USCFCCCHR OR

IF CONTRACTOR DESIRES CFPUA WATER FOR CONSTRUCTION, HE SHALL APPLY IN ADVANCE FOR THIS SERVICE AND MUST PROVIDE A REDUCED PRESSURE ZONE (RPZ) BACKFLOW PREVENTION DEVICE ON THE DEVELOPER'S SIDE OF THE WATER METER BOX. 7. WHEN PVC WATER MAINS AND SERVICES ARE PROPOSED, THE PIPES ARE TO BE MARKED WITH NO. 10 INSULATED, SINGLE-STRAND COPPER WIRE INSTALLED & STRAPPED TO THE PIPES WITH DUCT TAPE. THIS IS TO BE ACCESSIBLE IN ALL VALVES AND METER BOXES TO AID $ar{z}$

8. SEWER GUARDS REQUIRED AT ALL MANHOLES. STAINLESS STEEL SEWER GUARDS REQUIRED AT MANHOLES LOCATED IN TRAFFIC AREAS. SERVICES SHALL BE PERPENDICULAR TO MAIN AND TERMINATE AT RIGHT-OF-WAY LINE. SERVICES IN CUL-DE-SACS ARE REQUIRED TO BE PERPENDICULAR OR MUST ORIGINATE IN MANHOLE AND TERMINATE AT RIGHT-OF-WAY LINE. 10. ALL SERVICES TYING INTO DUCTILE IRON MAINS SHALL BE CONSTRUCTED OF CLASS 50 D.I.P. WITH PROTECTO 401 CERAMIC EPOXY LINING. 11. MINIMUM 10' UTILITIES EASEMENT PROVIDED ALONG THE FRONTAGE OF ALL LOTS AND AS SHOWN FOR NEW DEVELOPMENTS.

14. THE CONTRACTOR IS RESPONSIBLE FOR THE LOCATION AND PROTECTION OF EXISTING UTILITIES DURING CONSTRUCTION. CALL NC811 AT 811 OR 1-800-632-4949, CONTRACTOR IS RESPONSIBLE FOR THE REPAIR AND REPLACEMENT OF ANY UTILITIES, CURB & GUTTER, PAVEMENT, ETC. THAT MAY BE BE DAMAGED DURING CONSTRUCTION. DAMAGED ITEMS SHALL BE REPAIRED TO AT LEAST THE QUALITY OR WORKMANSHIP

15. THE BELLSOUTH CONTACT IS STEVE DAYVAULT, BUILDING INDUSTRY CONSULTANT, AT 910-392-8712. CONTACT HIM PRIOR TO STARTING THE PROJECT IN ORDER TO FACILITATE GOOD COMMUNICATION AND MAXIMUM FLEXIBILITY. 16. THE PROCESS FOR TELEPHONE CABLE PLACEMENT: * FINAL GRADE WILL NEED TO BE ESTABLISHED. * POWER WILL PLACE THEIR CABLE FIRST - APPROXIMATELY 3' DEEP. * BELLSOUTH & CABLE TV WILL THEN PLACE THEIR CABLE AT APPROXIMATELY 2' DEEP.

18. SHOULD ADDITIONAL SERVICES BE LOCATED DURING CONSTRUCTION, THEY MUST EITHER BE UTILIZED OR ABANDONED. 19. 3' SEPARATION BETWEEN JOINTS, FITTINGS, SERVICE SADDLES AND WYES ARE REQUIRED FOR SS AND WATER TAPS.

20. WATER SERVICES ARE TO BE DIRECTIONAL DRILLED. SAWCUT/EXCAVATION OF GREENVILLE AVE. SHOULD NOT BE REQUIRED. IF GREENVILLE AVE. IS SAW CUT, A 10' CUTBACK FROM EXCAVATION, MILLING, AND FULL ASPHALT OVERLAY WILL BE REQUIRED. 21. CONTRACTOR TO VERIFY THAT EXISTING 15" CPP ALONG PARK AVE. IS IN GOOD CONDITION AND IS FREE FROM ANY DEBRIS AND OR

ALL WEATHER ACCESS ROAD MUST BE MAINTAINED AROUND CONSTRUCTION SITE AT ALL TIMES. HYDRANTS SHALL BE OF SUFFICIENT NUMBERS TO ACCOMMODATE BASE FIRE FLOW REQUIREMENTS OF STRUCTURE. NEW HYDRANTS MUST BE BROUGHT INTO SERVICE PRIOR TO COMBUSTIBLE MATERIALS DELIVERED TO JOB SITE. 4. IN ADDITION TO THE STANDARD COMMENTS, ADDITIONAL FIRE PROTECTION AND ACCESSIBILITY REQUIREMENTS MAY BE REQUIRED DUE TO

1. ALL PAVEMENT MARKINGS IN PUBLIC RIGHTS-OF-WAY AND FOR DRIVEWAYS ARE TO BE THERMOPLASTIC AND MEET CITY AND/OR NCDOT STANDARDS. [DETAIL SD 15-13 & SD 11-3 COFW TECH STDS] 2. ALL SIGNS AND PAVEMENT MARKINGS IN AREAS OPEN TO PUBLIC TRAFFIC ARE TO MEET MUTCD (MANUAL ON UNIFORM TRAFFIC CONTROL

DEVICES) STANDARDS. [DETAIL SD 15-13 & SD 11-3 COFW TECH STDS] 3. ALL TRAFFIC CONTROL SIGNS AND MARKINGS OFF THE RIGHT-OF-WAY ARE TO BE MAINTAINED BY THE PROPERTY OWNER IN ACCORDANCE

4. A UTILITY CUT PERMIT IS REQUIRED FOR EACH OPEN CUT OF A CITY STREET. NOTE THIS ON THE PLAN AND CONTACT 341-5888 FOR MORE DETAILS. IN CERTAIN CASES AN ENTIRE RESURFACING OF THE AREA BEING OPEN CUT MAY BE REQUIRED. 5. IT SHALL BE THE RESPONSIBILITY OF THE SUBDIVIDER TO ERECT OFFICIAL STREET NAME SIGNS AT ALL INTERSECTIONS ASSOCIATED WITH THE SUBDIVISION IN ACCORDANCE WITH THE TECHNICAL STANDARDS AND SPECIFICATIONS MANUAL. THE SUBDIVIDER MAY ACQUIRE AND ERECT OFFICIAL STREET NAME SIGNS OR MAY CHOOSE TO CONTRACT WITH THE CITY TO INSTALL THE STREET SIGNS AND THE SUBDIVIDER

SHALL PAY THE COST OF SUCH INSTALLATION. CONTACT TRAFFIC ENGINEERING AT 341-7888 TO DISCUSS INSTALLATION OF TRAFFIC AND STREET NAME SIGNS. PROPOSED STREET NAMES MUST BE APPROVED PRIOR TO INSTALLATION OF STREET NAME SIGNS. 6. ANY BROKEN OR MISSING SIDEWALK PANELS, DRIVEWAY PANELS AND CURBING WILL BE REPLACED. 7. A LANDSCAPING PLAN INDICATING THE LOCATION OF REQUIRED STREET TREES SHALL BE SUBMITTED TO THE CITY OF WILMINGTON TRAFFIC


ENGINEERING DIVISION AND PARKS AND RECREATION DEPARTMENT FOR REVIEW AND APPROVAL PRIOR TO THE RECORDING OF THE FINAL


8. CONTACT TRAFFIC ENGINEERING AT 341-7888 FORTY-EIGHT HOURS PRIOR TO ANY EXCAVATION IN THE RIGHT OF WAY. 9. ALL PROPOSED VEGETATION WITHIN SIGHT TRIANGLES SHALL NOT INTERFERE WITH CLEAR

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truction Plan		
<u> </u>	<u>Date</u>	

	 	• 2	- SETBACK RUNOFF CENTER I PROPOSE PROPOSE 5.5 SPOT ELE	D LOTLINE S DIRECTION LINE D WATERLINE D SANITARY S	EWER LINE
30'	15'	0'	30)'	60'



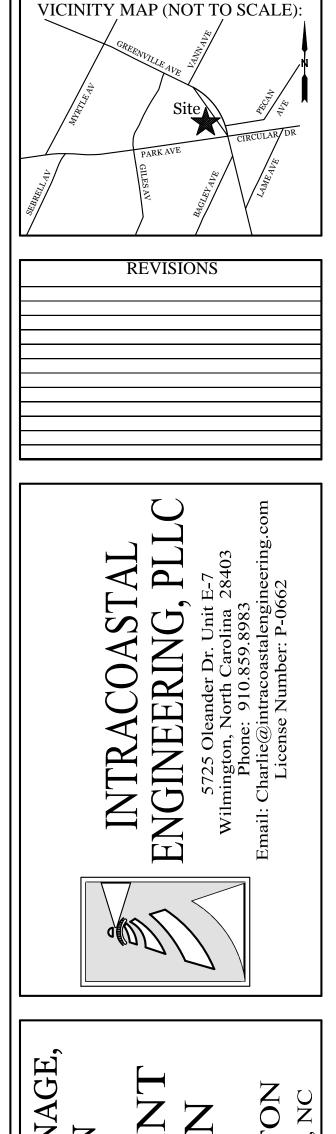

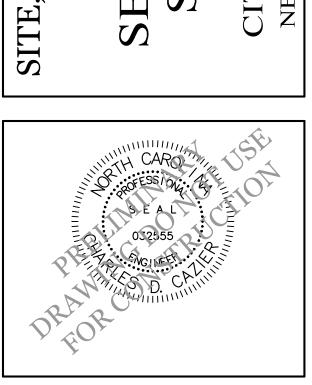CLIENT INFORMATION:

DRAI

PL

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GRADING, & UTILITIES

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Three Feathered Friends LLC Steve Campbell 1601 Limpkin Ct Wilmington, NC 28403 Phone: (910) 471-2613

DRAWN:	JAE	SHEET SIZE:	24x36
CHECKED:	CDC	DATE:	1/24/2020
APPROVED:	CDC	SCALE:	1" = 30'
PROJECT NUMBE	ER:	2018-031	

C-1

DRAWING NUMBER:

